

Code Analysis 2426 Pennsylvania Ave.

Usc Group A (Assembly) Construction Type Height 2 storics/32 Ft. 4620 SF Arcas First Floor 528 SF Mezzanine Second Floor 3960 SF 660 SF Balcony Total 9768 SF 420 SF Area of Construction

Work confined to Marquee and new Electrical Room

Applicable Codes & Standards

IEBC 2015

IBC 2015

Secretary of the Interior's Standards for Rchabilitation

1.1 Scope. Steel Chains to be 7/8" Stud Link Anchor Chains by Blue Ocean Tackle or

Section 05 41 00: Metal Stud Framing

1.1 Scope. See Structural Drawings for sizes of metal stude of marquee.

1.2 Submission. Contractor to submit shop drawing for placement of metal stub framing for review and approval of Architect prior to installing.

1.3 Electrical Panel wall. New electrical panel wall to be 20 ga. 3 5/8" metal studs at 16" on center with 5/8" sheetrock on closet side only. Brace as required to hang Electrical

Section 05 75 00: Decorative Formed Metal

1.1 Scope. See Architectural Drawings for intent of Decorative Formed Metal design

1.2 Submission. Contractor to submit shop drawing of Decorative Formed Metal for review and approval of Architect prior to fabrication.

1.3 Metal Cresting. Metal Cresting No. 5076, 4 1/2" high by W.F. Norman Corporation. 1.4 Color. Decorative Formed Metal to "Copper Penny" or equal. Contractor to submit color samples to Architect for review and approval prior to fabrication.

1.5. Gauge. Contractor to advise Architect of appropriate metal gauge of Decorative Formed Metal.

Section 07 50 00: Membrane Roofing and Flashing

1.1 Materials. Thermoplastic single ply roof membrane by Johns Manville or equal.

1.2 Flashing. Flashing and counter flashing to be per manufacturer's specifications. 1.3 Cants and Curbs. All cants and curbs are to be of pressure treated wood.

1.4 Slope. Slope to gutters and/roof drains for positive drainage as shown on drawings.

1.5 Ventilation. See Section 07 72 00 for ventilation requirements.

Section 07 62 00: Flashing, Gutters, Downspouts, and PVC Drains 1.1 Scope. Metal flashing, gutters and downspouts, and PVC drains.

1.2 Gutters and Downspouts. 5" half round 0.32" aluminum gutters by RDCA or equal.

Color: Granite. Round Downspouts to match

1.3 Flashing. Aluminum Sheet conforming to ASTM B209, 0.167" thick.

1.4 PVC Drains. Downspouts to connect to PVC drains with cleanout 6" above grade and extend under sidewalk to daylight at curb. Exposed PVC to be painted to match

1.5 Installation of Flashing. Install flashings to form water tight fit. Make corners square, surfaces true and straight in planes, and lines accurate to profiles. Seal metal joints watertight.

1.6 Installation of Gutters and Downspouts. Secure gutters and downspouts in place using aluminum fasteners. Slope gutters 1/4 inch per foot to downspouts.

1.2 Temporary Storage and Use of Public Space. Contractor shall be responsible for securing and paying for permission and permits necessary to store materials, site offices, staging, and other use of the public sidewalk or street, alley or other public locations.

1.1 Scope. The Work comprises all labor, equipment, materials, and services necessary

for the reconstruction of the Marquee and associated electrical and acoustical work at

2426 Pennsylvania Avenue Baltimore, Maryland. All work shall be in conformance with

1.2 Codes. The Work shall conform to the most recent edition of the International

Building Code, and all applicable City, State, and National laws, rules and regulations

1.3 Standards. The Work shall conform to the Secretary of the Interior's Standards for

1.4 Verification. Contractor shall verify all conditions, materials, measurements,

1.5 Permits. Contractor shall obtain and pay for all permits, licenses, and permissions

1.1 Scope. Contractor shall be responsible for coordinating all aspects of the Work,

including but not limited to ordering, storing, and delivery of materials and supplies,

1.3 Schedule. Contractor shall be responsible for developing a construction schedule prior to commencing the Work. The schedule shall be reviewed and approved by the Architect and Owner prior to commencing the Work. 1.4 Submittals. Contractor shall submit all preliminary shop drawings, product data,

and samples for review and approval by the Architect. 1.5 Change Orders. Contractor shall submit all requests for Change Orders,

Alternatives, and Substitutions for review and approval to the Architect. The Owner shall approve all reasonable requests for Change Orders approved by the Architect in a timely fashion.

1.6 Requests for Information. Contractor shall respond in a timely manner for all reasonable requests for information from the Architect or Owner. The Owner and Architect shall respond in a timely fashion for all Requests for information from the

1.7 Inspection by the Architect. Architect shall inspect the Work on a regular basis. The Architect shall provide the Contractor with reasonable notice of date and time of inspections. Contractor to supply and facilitate access to all areas of the Work being

Section 07 72 00: Marquee Vent

1.1 Scope. One 60 Sq. inch metal vent, painted to match color of Decorative Formed Metal with insect screen. See Architectural Drawings for location.

Section 08 02 00: New Wood Windows

1.1 New Windows. New windows to match existing as closely as possible in design, glazing reflectivity and materials.

1.2 Submittals. Contractor to provide manufacturer's product data to the architect for

1.3 Wood Sash. New wood sash is to be installed in original wood jambs, heads and sills, modified as required.

Section 23 00 00 HVAC

Specifications

2426 Pennsylvania Ave

pertaining to the Work.

necessary to earry out the Work.

labor and Sub-Contractors.

Rehabilitation.

Section 01 11 00: Summary of Project

the drawings, notes, and specifications herein.

quantities, and dimensions before beginning the Work.

Section 01 31 00: Project Management and Coordination

1.1 Investigation. Contractor is responsible for investigating location of HVAC systems that may be affected by the Work. If found, it is to be brought to the attention of the Architect as soon as possible for resolution.

1.2 Relocation. Possible relocation of HVAC affecting this Work is not part of the current Work. Contractor may be asked to provide estimate for relocation Work and if accepted, carry out the relocation.

Section 26 50 00 Electrical

1.1 See Electrical Drawings for extent and specifications for electrical Work.

Section 26 56.00

1.1 See Electrical Drawings for locations and types of lighting, and relocated panel box.

Section 27 40 00 Audio Visual System

1.1 Audio. See Darnley Sound Labs for specifications. See Reflected Ceiling Plans for locations of speakers.

1.2 Videos Screen. See Watchfire for specifications.

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CHITECTS

Marquee Social Club ennsylvan Permit rch N 24

July 2020

Sheet Title:

Revisions:

PLAT CODE ANALYSIS **SPECIFICATIONS**

Project Number: Drawn By: Checked By HP RW 004-19

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Sheet Number:

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Section 02 41 91: Selective Demolition

permits related to hazardous material remediation.

before the Architect shall conduct the Final Inspection.

labor Guarantees and Warranties.

hazardous material.

completion of remediation.

Section 02 26 00: Hazardous Materials

by the Work or that will require remediation.

1.1 Demolition. Portions of the existing building to be demolished are noted on the Architectural Drawings. Contractor shall not demolish any portion of the existing building, including finishes, not so noted on the Drawings without first consulting with the Architect.

1.8 Closeout. Contractor shall notify the Architect and Owner when the Work is

considered ready for Substantial Completion Inspection. The Architect shall conduct

the Inspection to determine items to be listed (punch list) for completion or correction.

Contractor shall comply with the Architect's instructions to correct and complete items

1.9. Lien Releases, Guarantees, and Warranties. At the time of the Final Inspection, the

Contractor shall provide the Owner with all Lien Releases; and product, materials, and

1.1 Identification. Contractor shall be responsible for hiring and paying for qualified

hazardous material contractor to identify any hazardous materials that may be disturbed

1.2 Environmental Regulations. Hazardous material abatement contractor is to comply

with all applicable federal, state, and local environmental regulations regarding testing,

handling, treatment, containment, collection, transport, disposal, and discharge of

1.3 Coordination of Work and Permits. Contractor shall be responsible for coordinating

the remediation of hazardous material as well as securing and paying for all necessary

1.4 Certification. Contractor is to provide Owner with signed certification of hazardous

material remediation including waste shipment and disposal immediately upon

1.2 Disposal of Waste. The Contractor shall dispose of all materials and waste in a manner approved by City, State, and Federal regulations, including the disposal of any and all hazardous materials and wastes.

Section 03 30 00: Concrete

1.1 Scope. Repair of concrete sidewalk.

1.2 Cutting and Patching. Cut concrete sidewalk as required to install PVC drain attached to downspouts (See Section 07 62 00). Patch with similar strength concrete.

1.3 Concrete Finishing. Finish to match existing.


Section 05 10 00: Structural Steel 1.1 Scope. See Structural Drawings.

Section 05 15 00: Steel Chains




PENNSYLVANIA AVENUE ELEVATION

1/4" = 1'-0"

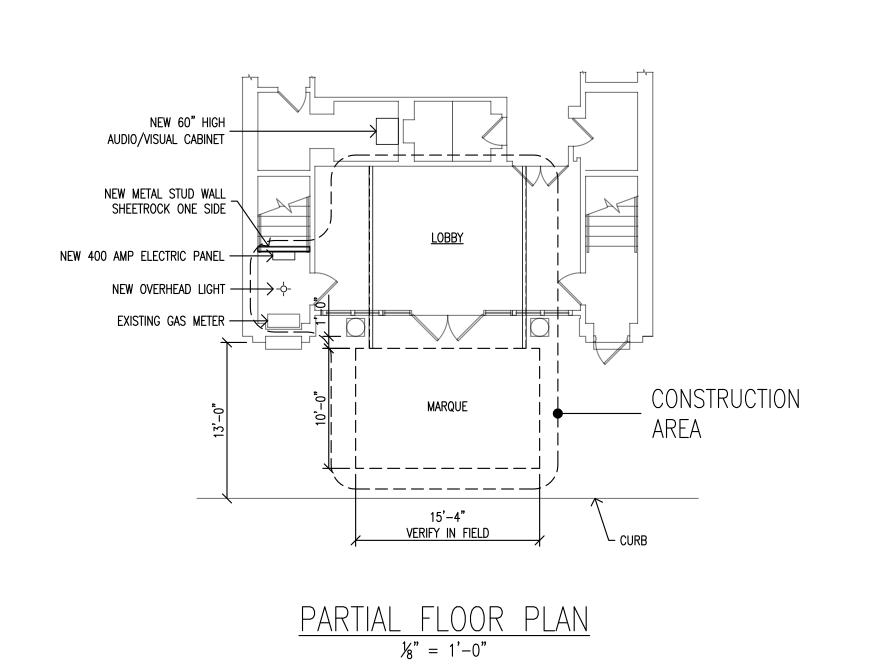



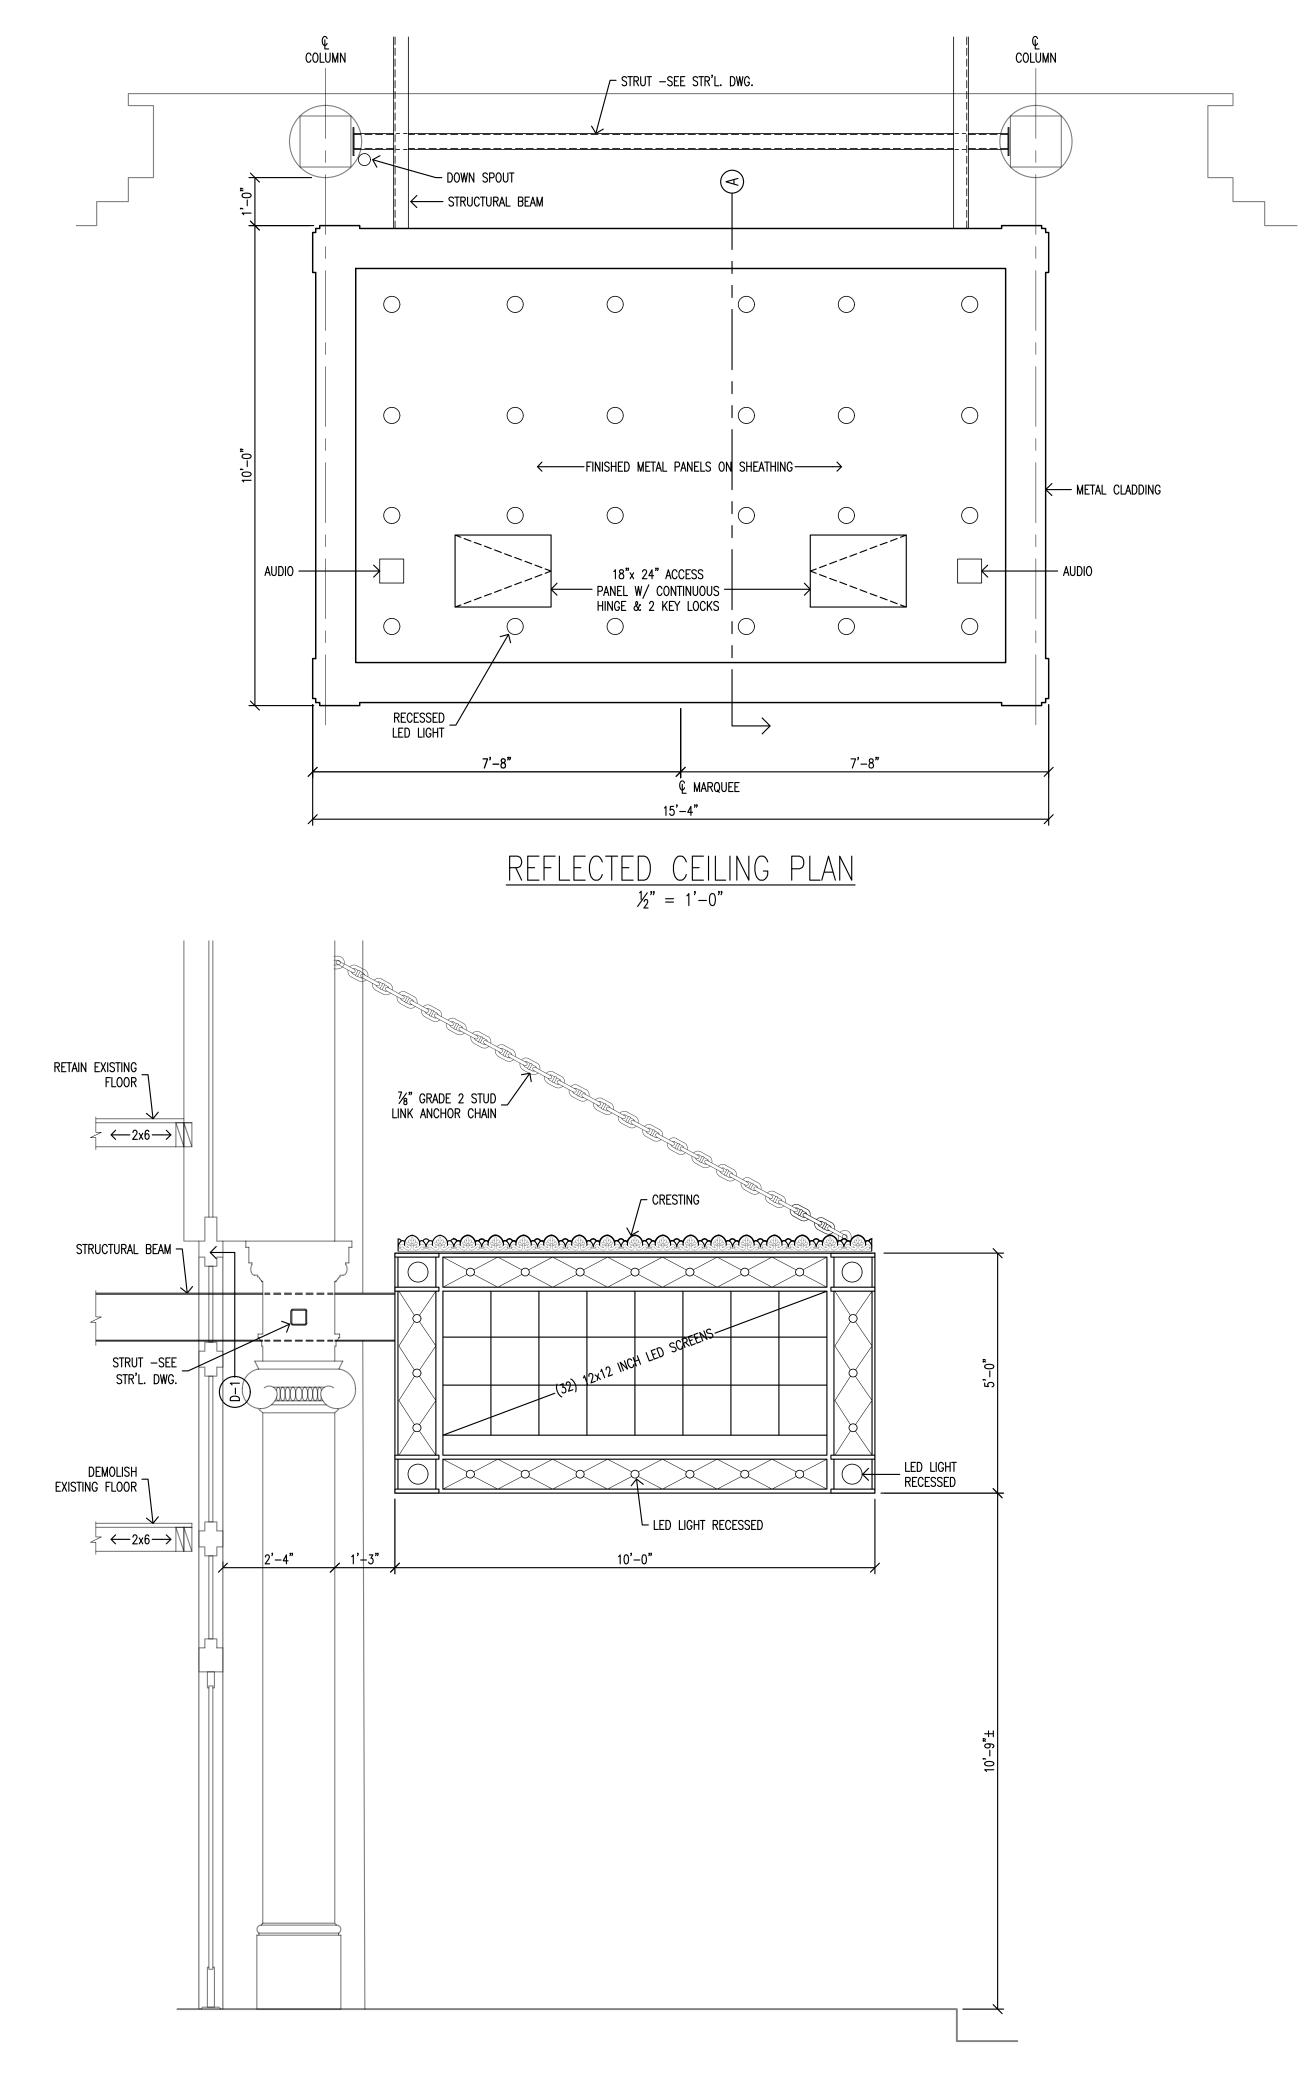

 $\frac{\text{SOUTH } \text{ } \text{ELEVATION}}{\cancel{2}" = 1"-0"}$

DAVID H. GLEASON ASSOCIATES, INC. ARCHITECTS

> Arch Social Club Marquee 2426 Pennsylvania Avenue

Date:
July 2020

Revisions:

Sheet Title:

PLAN & ELEVATION

Project Number: Drawn By: Checked By:
004-19 HP RW

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